




REAR ELEVATION
SCALE 1/8"=1'-0"

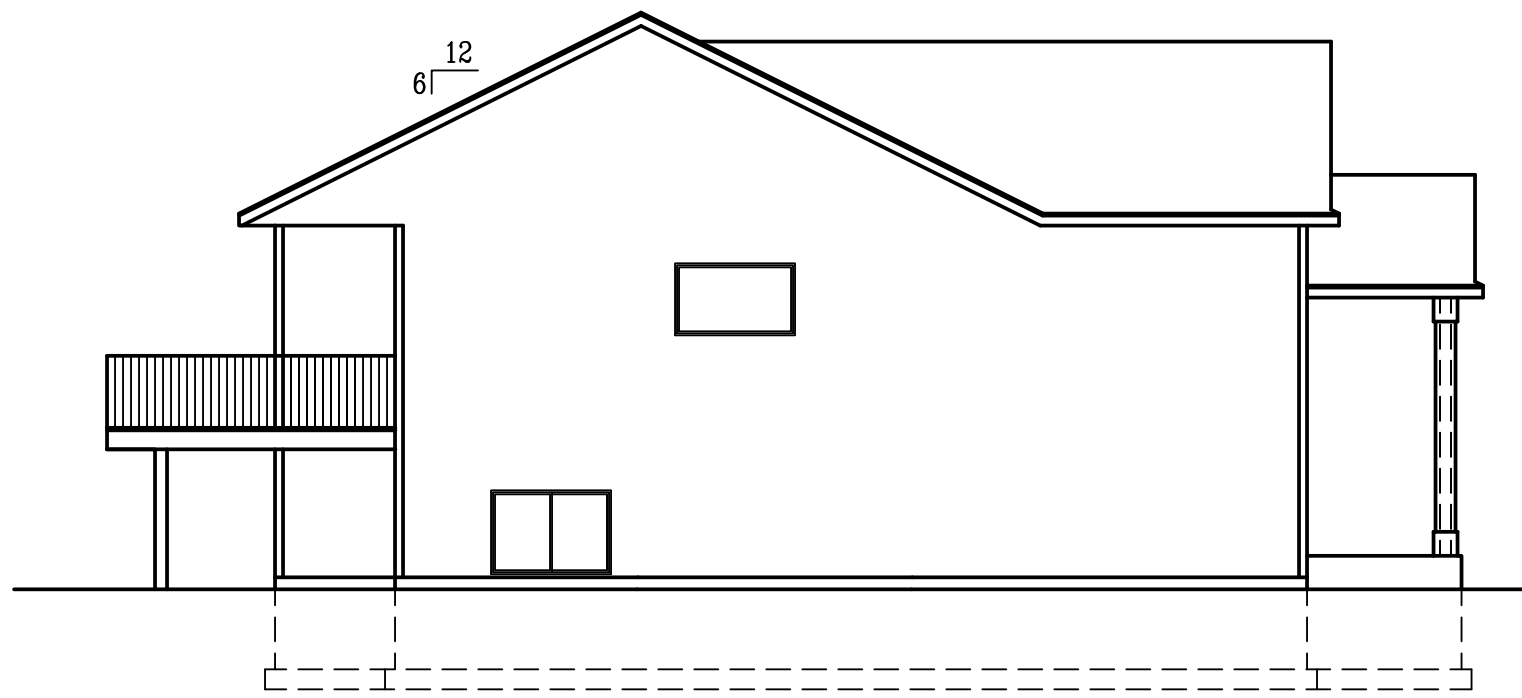

LEFT ELEVATION
SCALE 1/8"=1'-0"

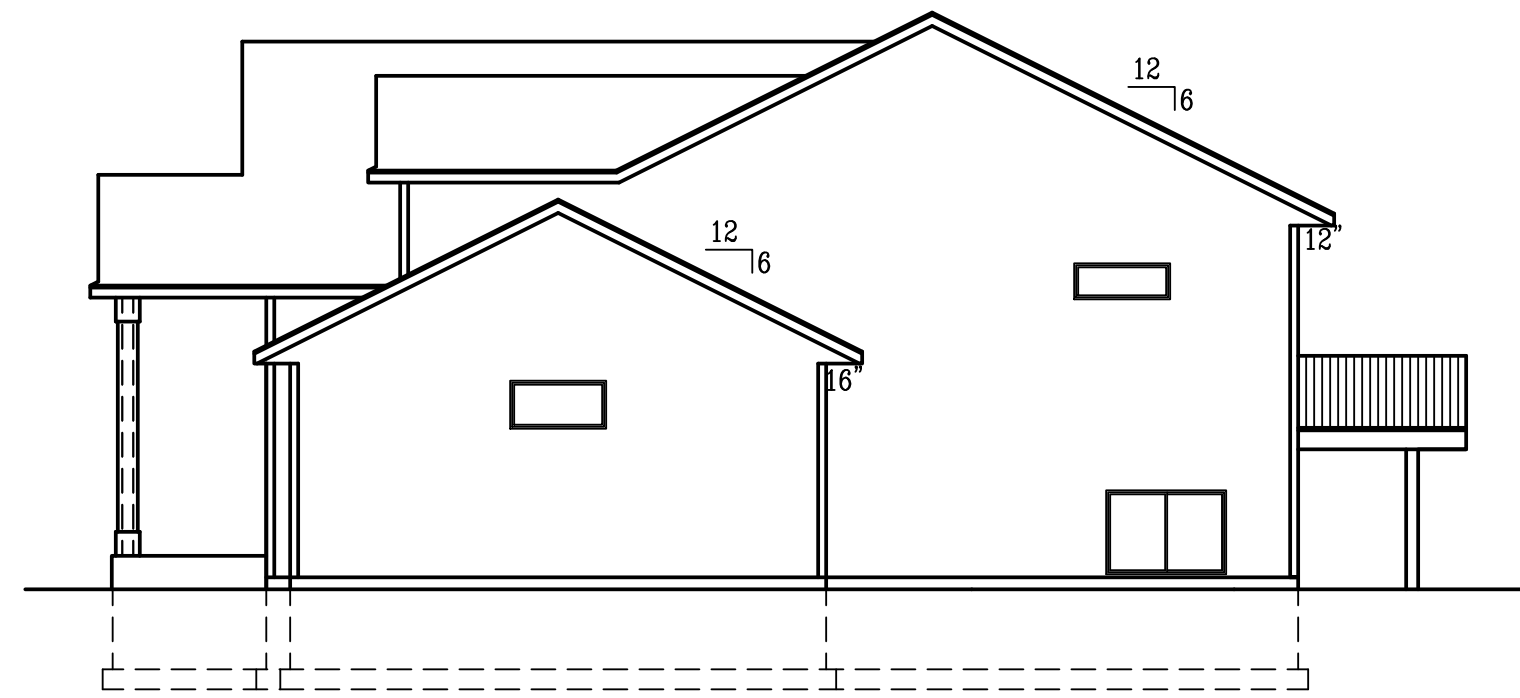

RIGHT ELEVATION
SCALE 1/8"=1'-0"

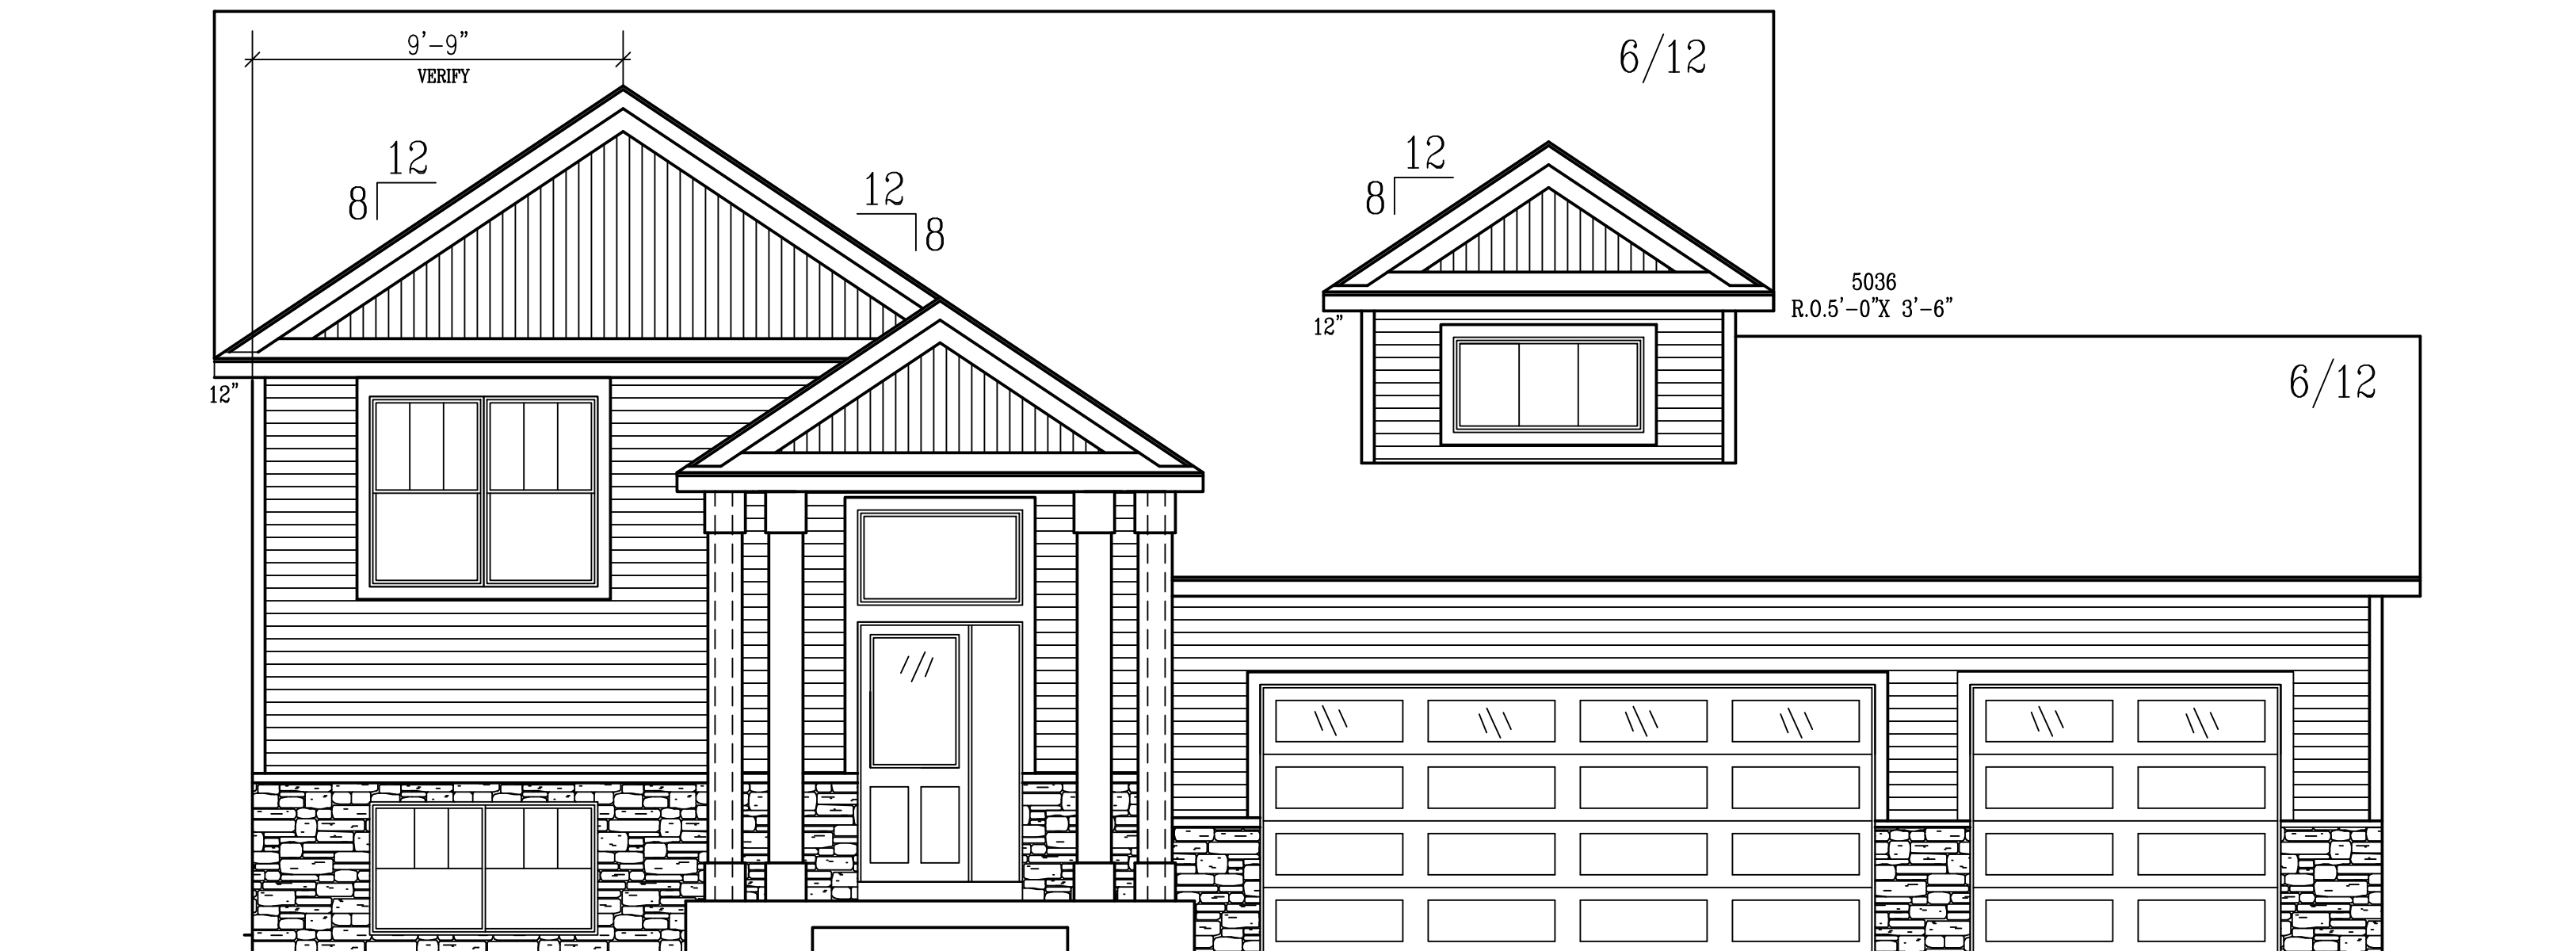

FRONT ELEVATION
SCALE 1/4"=1'-0"

**PROGRESSIVE PLAN
DESIGN LLP**
RESIDENTIAL ARCHITECTURE
714 County RD. 3 NW Byron MN 55920
(507-775-6877) progressiveplandesign@gmail.com

These drawings have been prepared using information provided by the customer/contractor who is solely responsible for the accuracy of the information provided. The drawings are not a substitute for permit drawings prepared by a contractor or architect and may not meet all applicable codes and practices. Before starting construction, the customer should consult with the contractor as a guide for builders who are knowledgeable about normal construction standards and local codes and practices. 2.) projects structural requirements; 3.) existing conditions specific to project or project site. Consult local building officials to determine if a building permit is required. Acknowledged by: _____ Customer/Contractor Signature _____ Date _____

CONTRACTOR:
BIG/LENN CONST.
OWNER:
NATURE RIDGE MOD. #18-1




DRAWN BY: **B.B.**
DATE: **07-20-23**
SQ. FT.
JOB NUM: **2313747**
SCALE: **NOTED**
SHEET: _____ OF _____

1/4"=1' 18x24

DISCRIPTION: MAIN FLOOR


BRACED PANEL LENGTH TABLE BASED ON WIND SPEED (<90mph)									
BRACED WALL LINE	BRACING METHOD TABLE R602.10.4.1	BRACED WALL LINE SPACING	REQUIRED BRACING LENGTH (FEET)	EXPOSURE FACTOR CONDITION	ROOF TO EAVE TOTAL	WALL HIGHT TOTAL	* ADJUSTMENT CALCULATION EXAMPLE		
							REQUIRED BRACING LENGTH	ROOF TO EAVE TOTAL	WALL HIGHT TOTAL
①	CS-WSP	18 FT.	6.45	1.0	1.0	0.95	1.3	8.0'	13.75'
②	CS-WSP	22 FT.	3.95	1.0	1.0	0.95	1.3	4.9'	20.0'
③	CS-WSP	22 FT.	6.45	1.0	1.0	0.95	1.3	8.0'	13.1'

Ⓐ	CS-WSP	56 FT.	8.4'	1.0	1.0	0.95	1.3	10.3'	16.0'
Ⓑ	CS-WSP	39 FT.	5.9'	1.0	1.0	0.95	1.3	7.3'	12.0'
Ⓒ	CS-WSP	39 FT.	5.9'	1.0	1.0	0.95	1.3	7.3'	12.0'

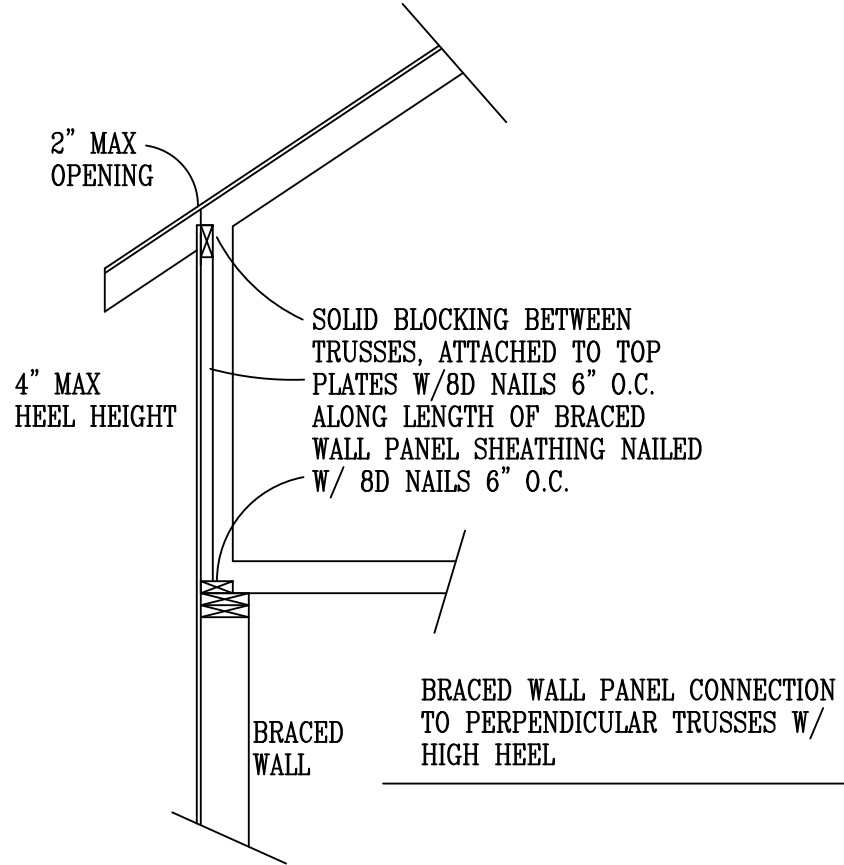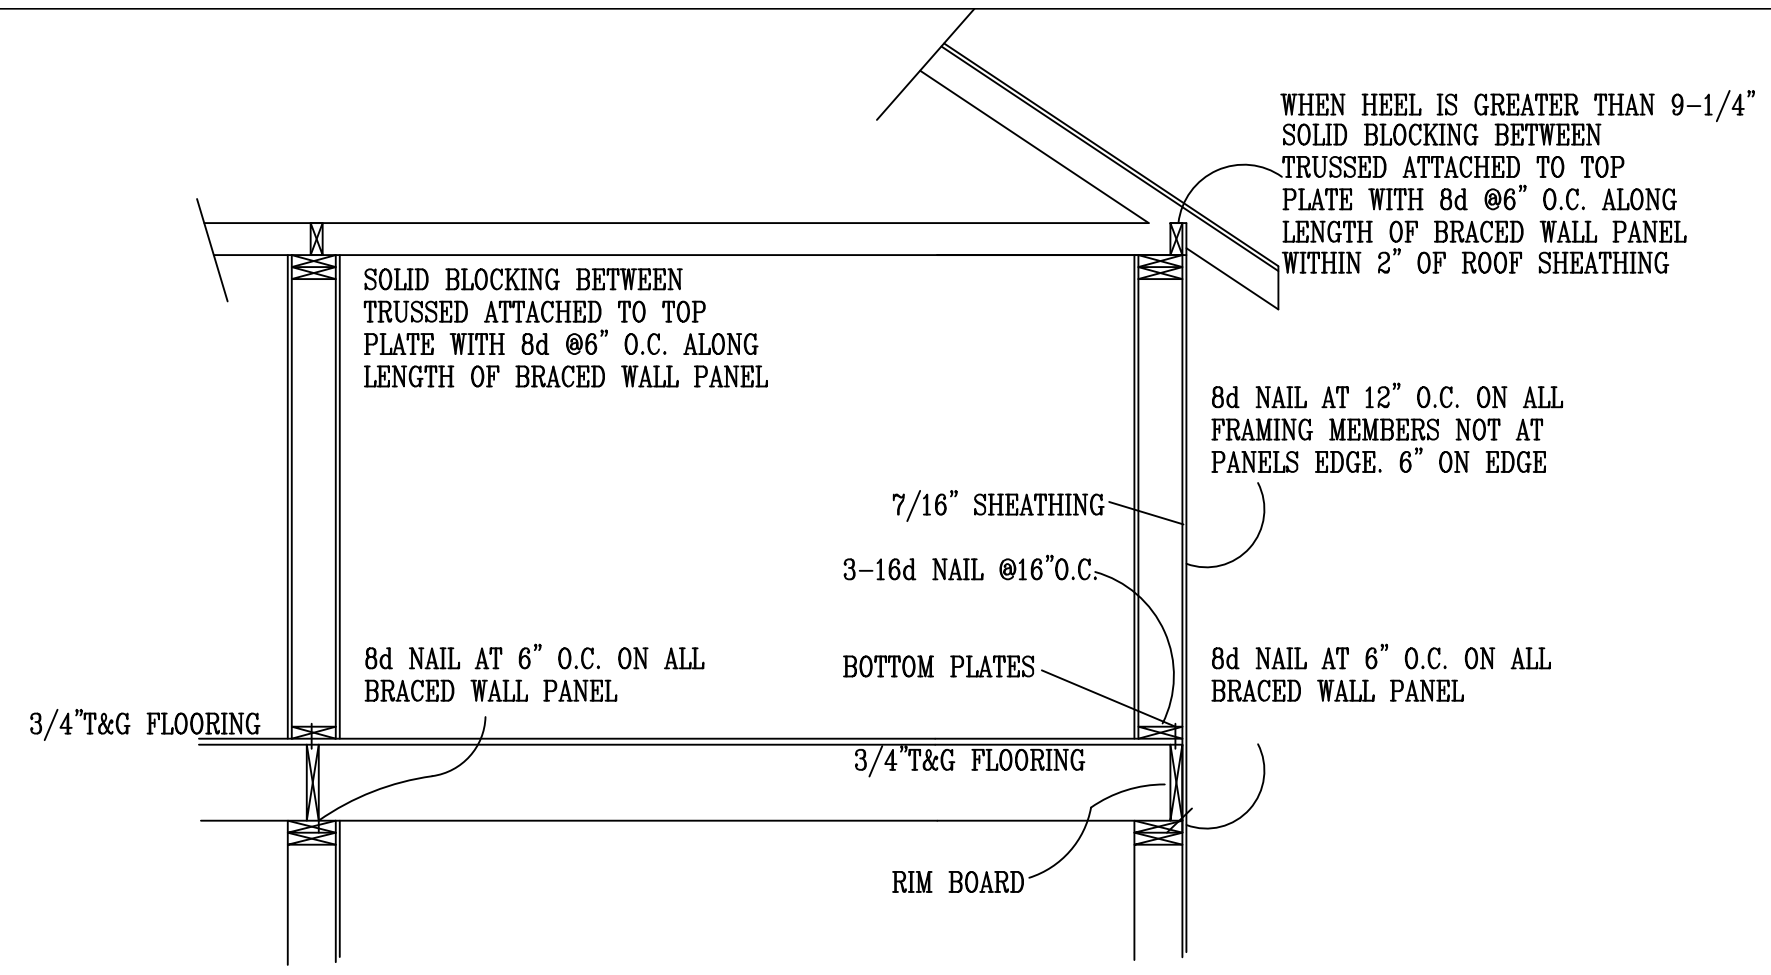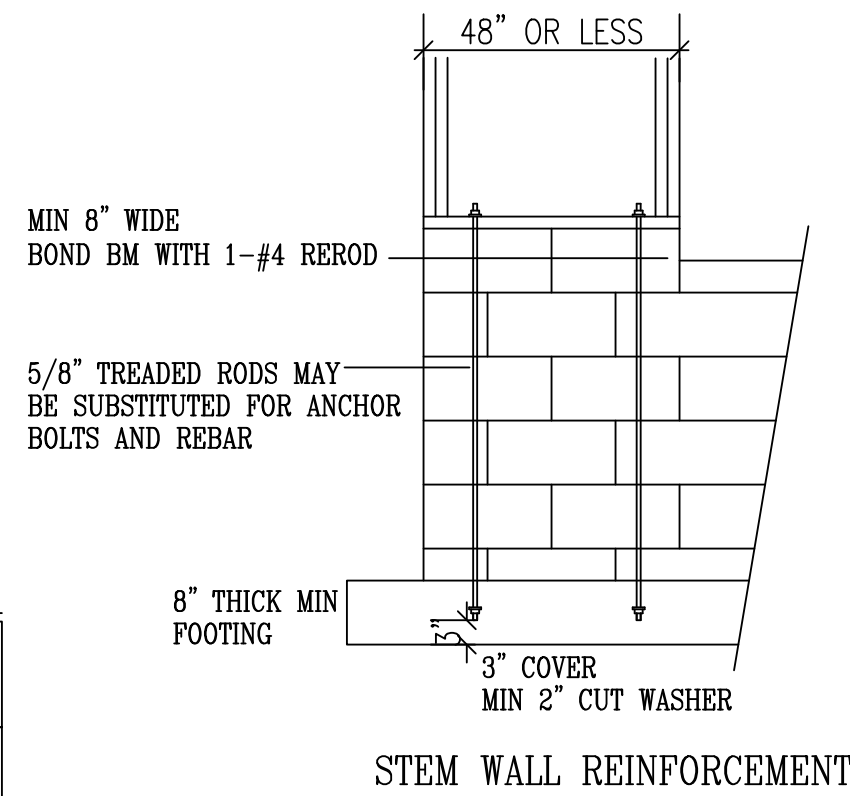


GB BRACED WALL PLATE FASTENED TO FLOOR W/ 3-16d NAILS @ 16\"/>

WALL BRACING NOTES CS-WSP
 1. ALL WALLS SHALL BE CONTINUOUSLY SHEATHED WITH WOOD STRUCTURAL PANELS
 2. CS-WSP ON PLANS INDICATE AREAS OF BRACED PANELS
 3. BRACED PANELS SHALL BE CONSTRUCTED WITH 16\"/>

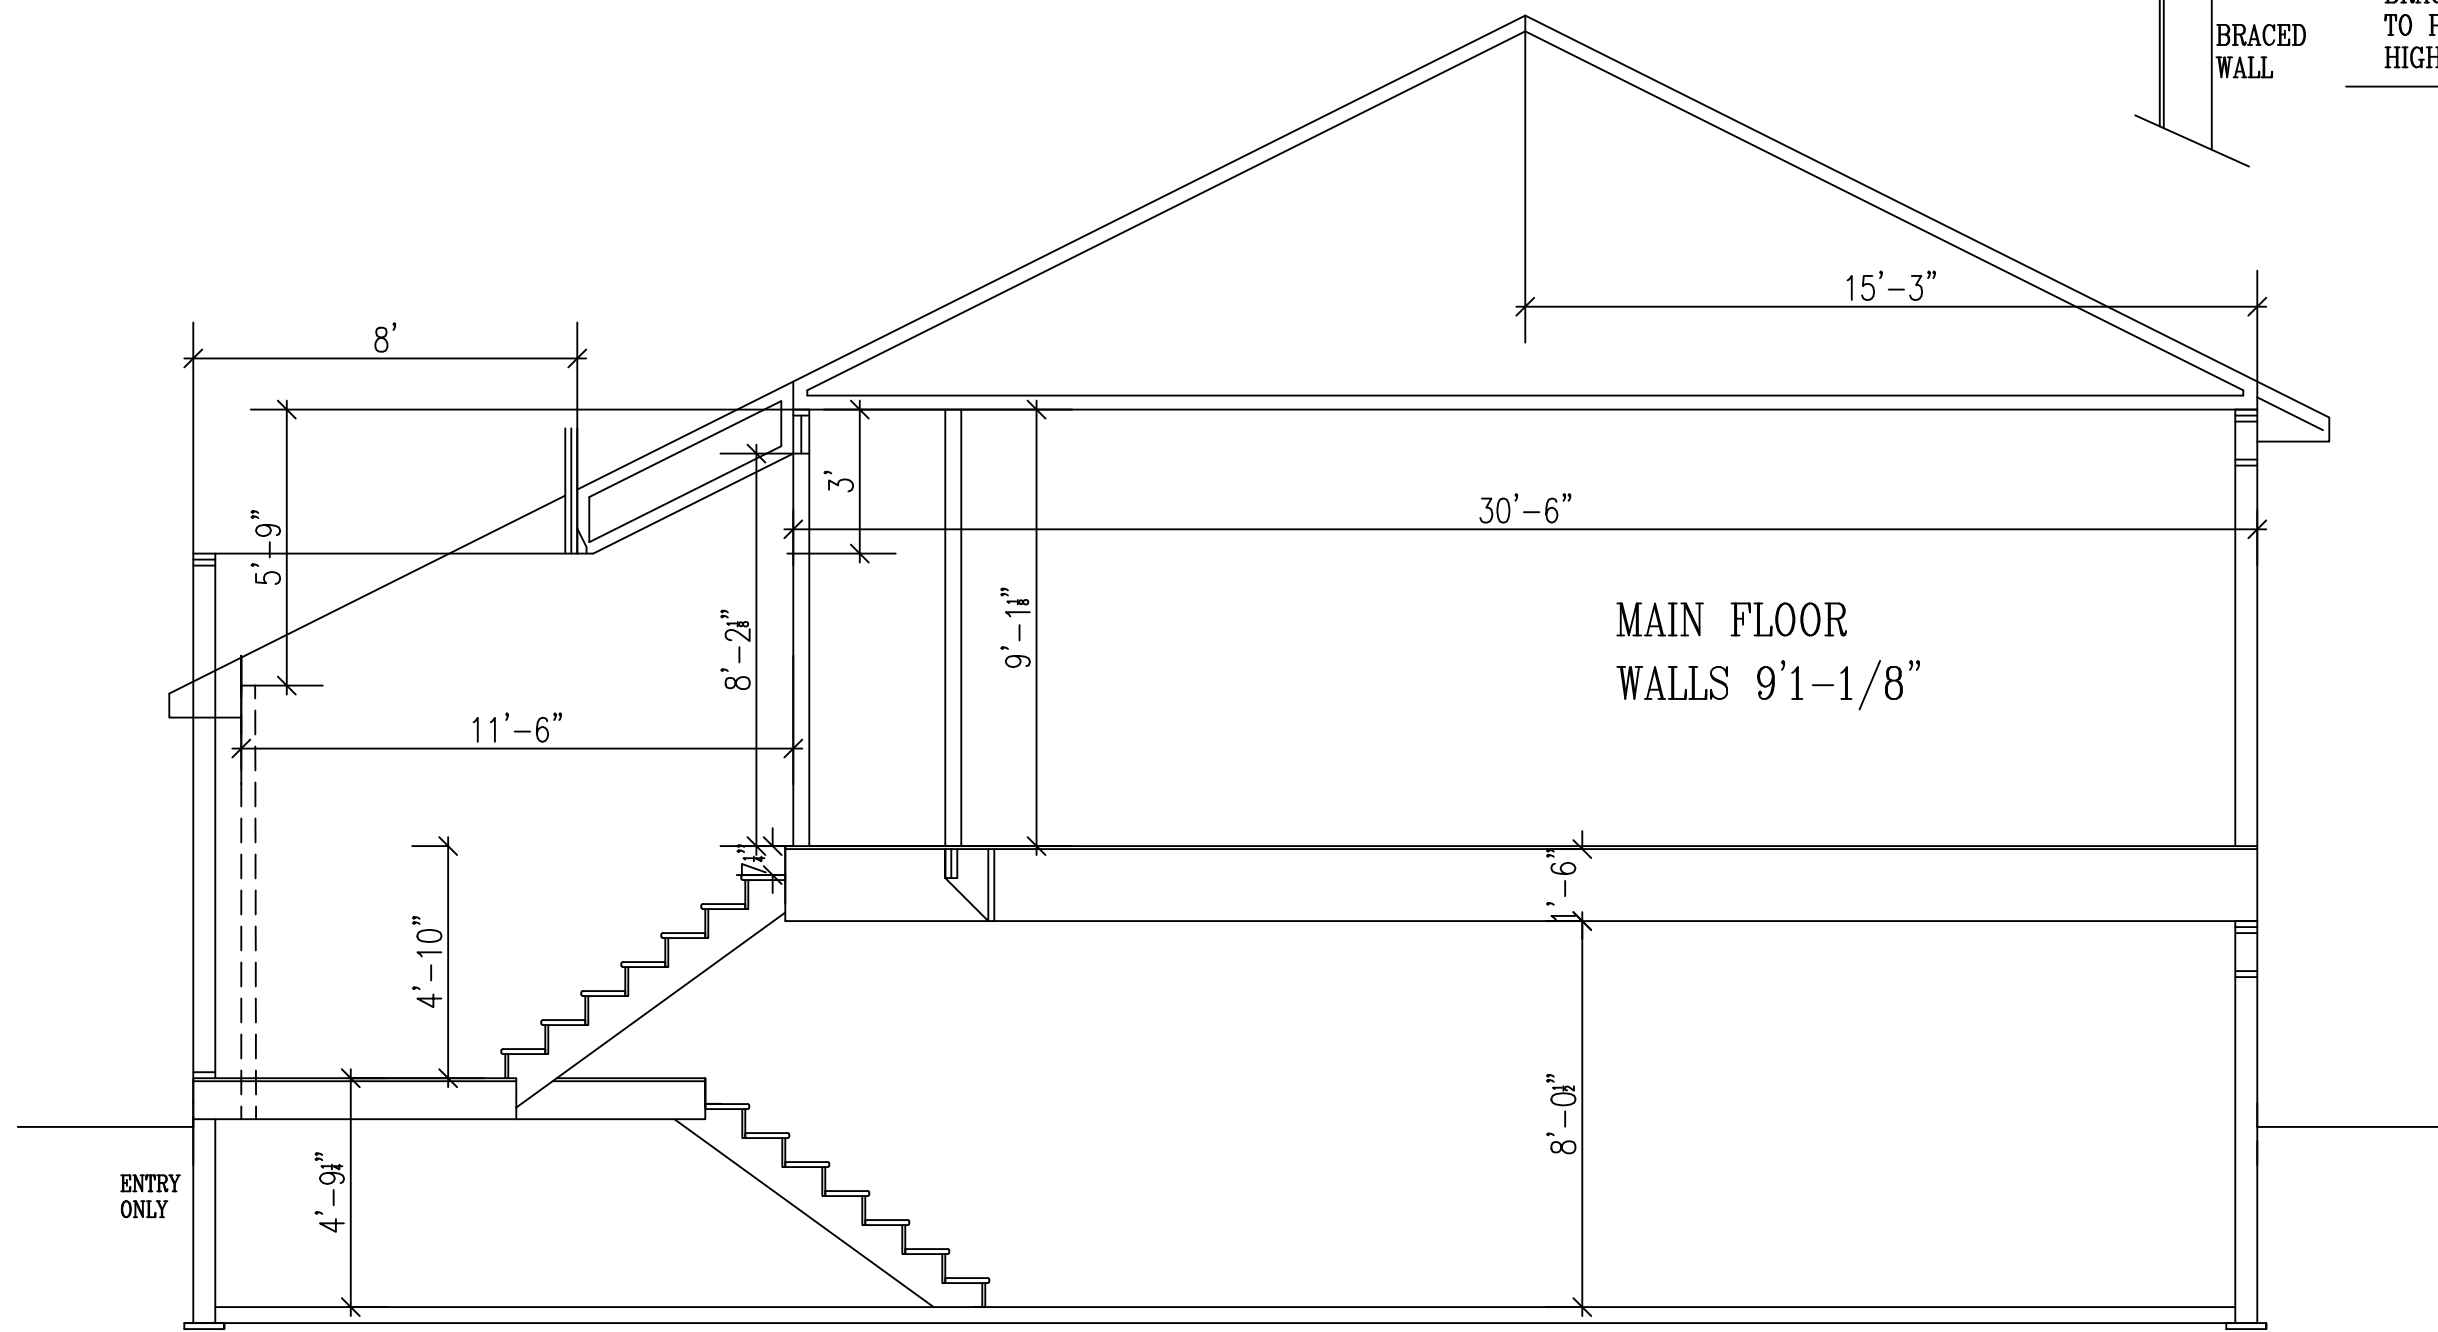

CROSS SECTION
SCALE 1/4" = 1'-0"

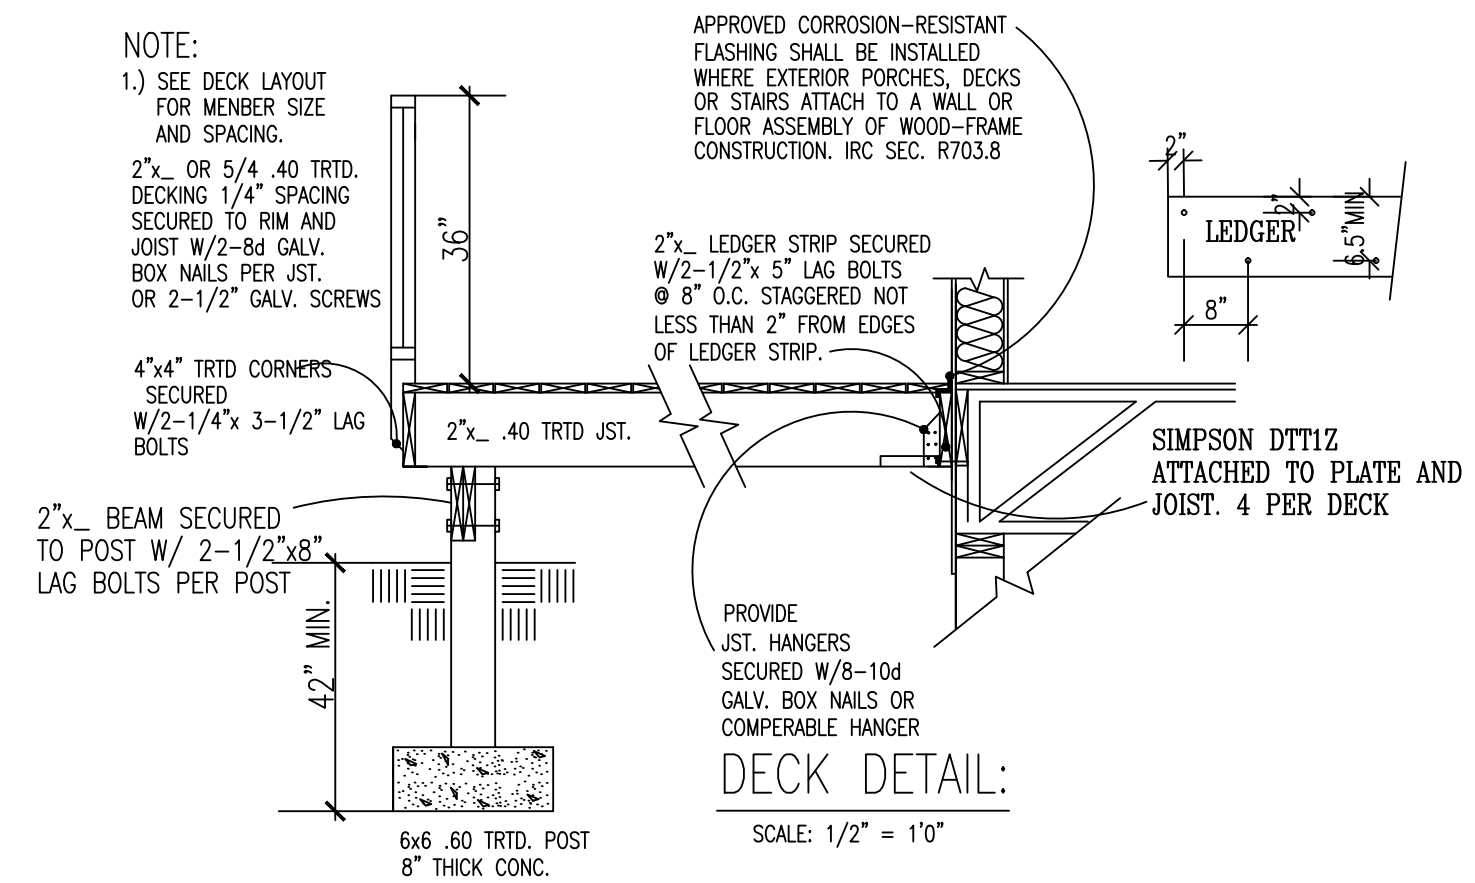

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 Acknowledged by _____ Customer/Contractor Signature _____ Date _____

CONTRACTOR: **BIG/LENN CONST.**
 OWNER: **NATURE RIDGE MOD. #18-1**

DRAWN BY: **B.B.**
 DATE: **07-20-23**
 SQ. FT.:
 JOB NUM: **2313747**
 SCALE: **NOTED**
 SHEET: _____ OF _____
 1/4" = 1'0" 18x24

